



NO.	DATE	BY	REVISIONS
1			
2			
3			
4			
5			
6			

APPROVED BY	DATE	REVIEWED BY SECTIONS
<i>[Signature]</i>	1/18/41	ARCHITECTURAL ENGINEERING LANDSCAPE
ASSISTANT CHIEF IN CHARGE	DATE	OF DESIGN
<i>[Signature]</i>	1-8-41	


DRAWN BY	DATE
E. J. R.	2-28-46
CHECKED BY	
E. J. R.	

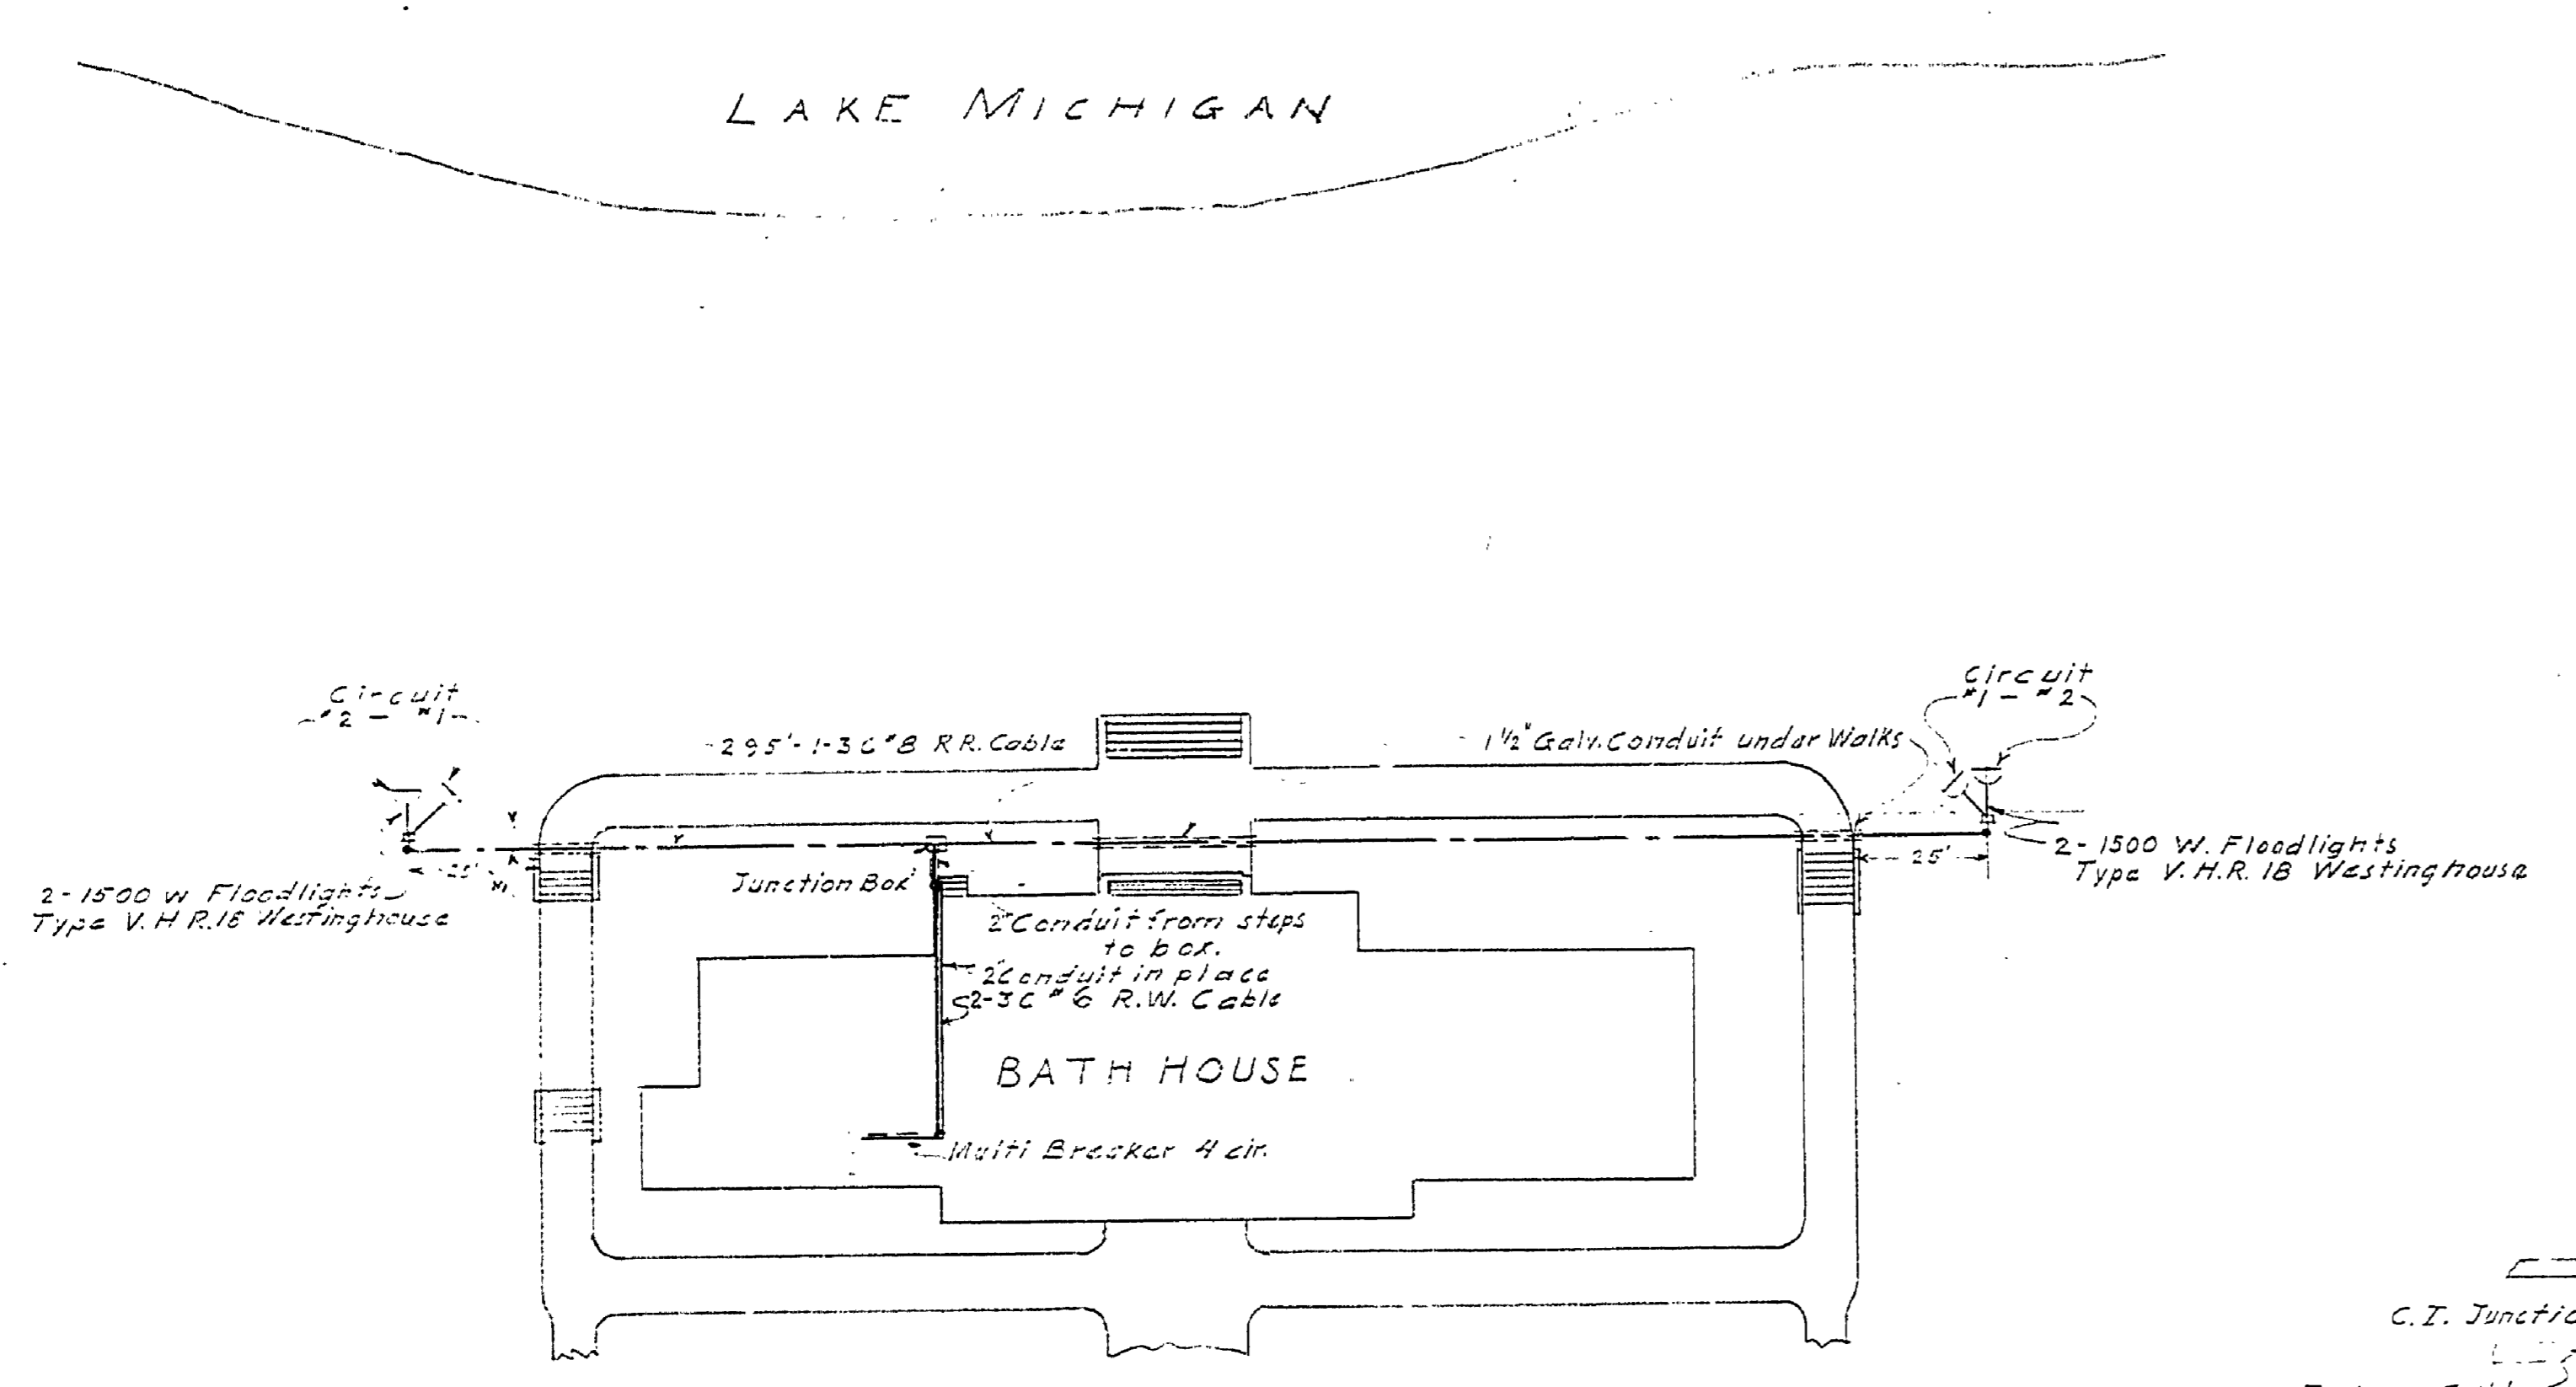


PLAN OF FLOODLIGHTS & CABLE LAYOUT
SCALE 1"=30'-0"

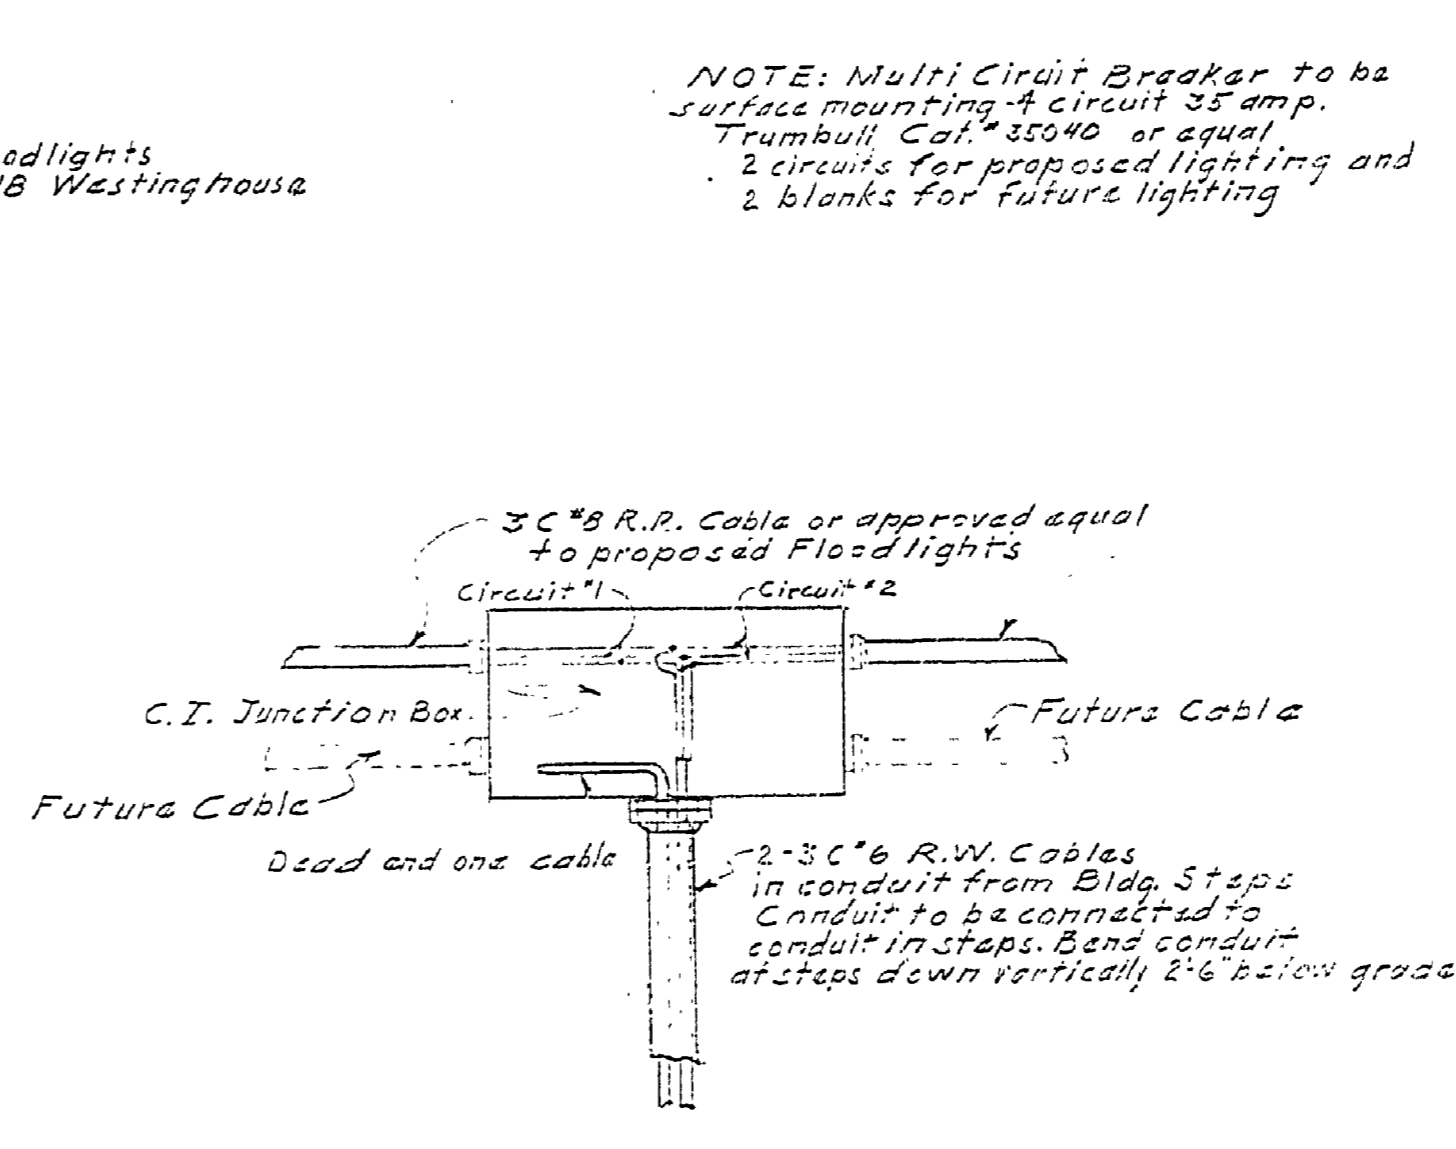

PLAN DETAILS JUNCTION BOX
NO SCALE

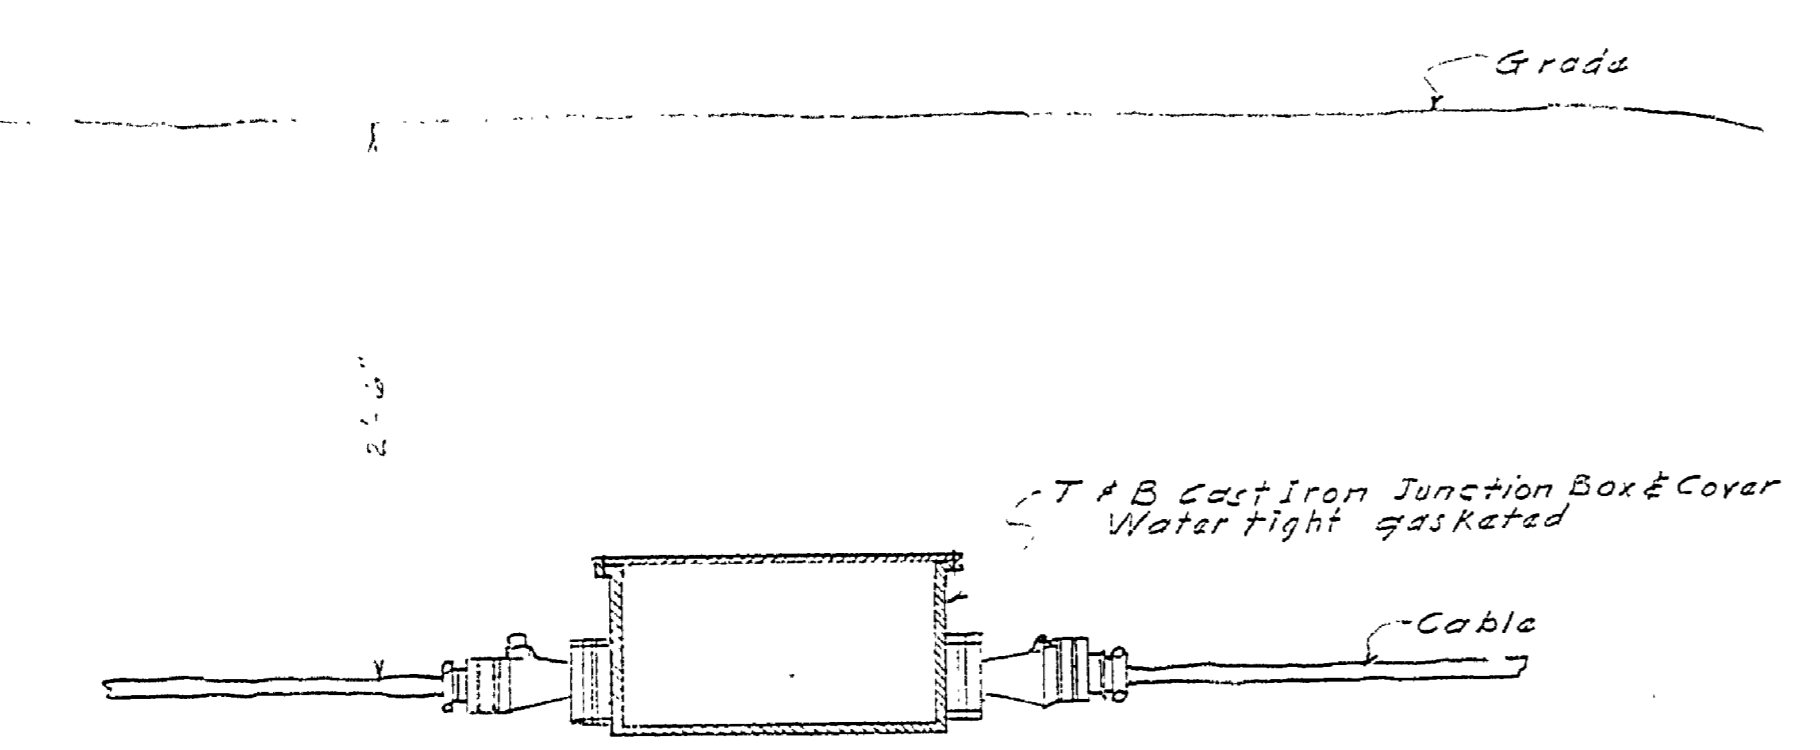


SECTION THRU CABLE TAP BOX
NO SCALE

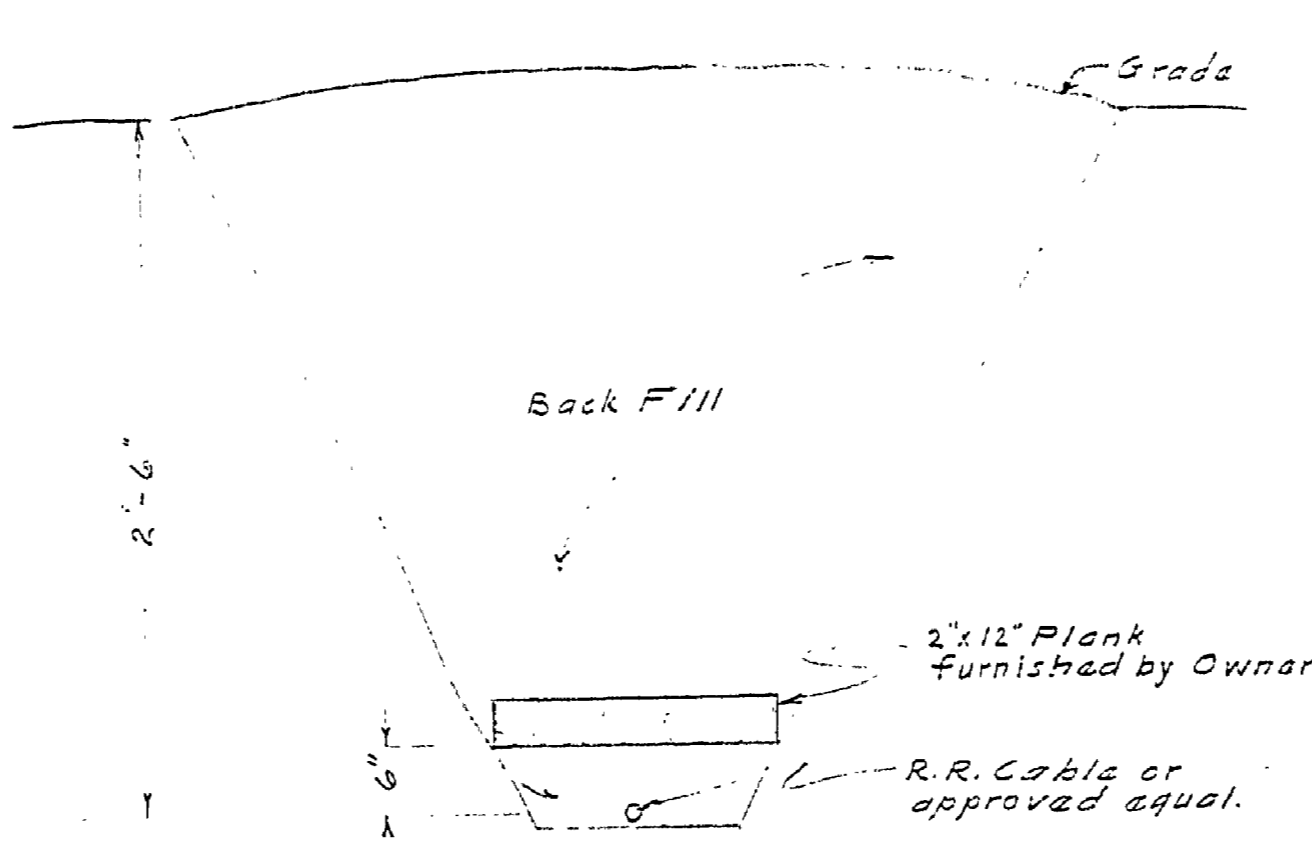


CROSS SECTION OF CABLE TRENCH
NO SCALE

NOTE: Multi Circuit Breaker to be surface mounting. 4 circuit 35 amp. Trumbull Cat. #35040 or equal. 2 circuits for proposed lighting and 2 blanks for future lighting.

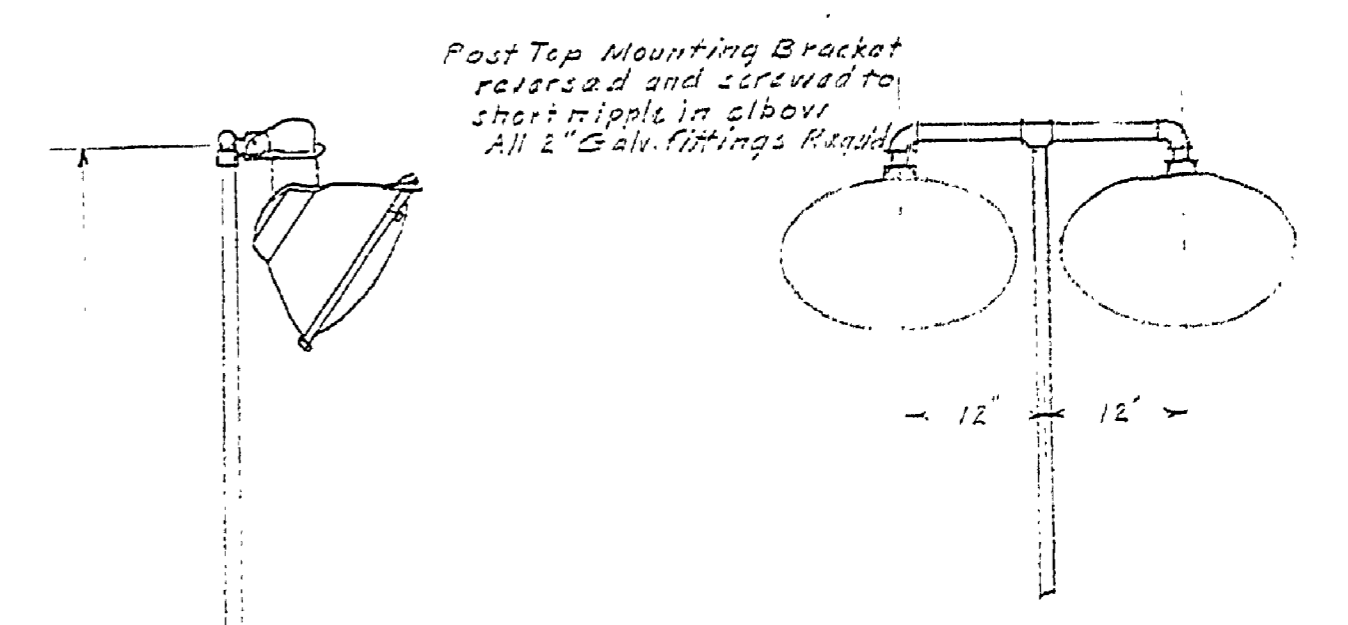

FRONT ELEVATION
SCALE 3/4"=1'-0"

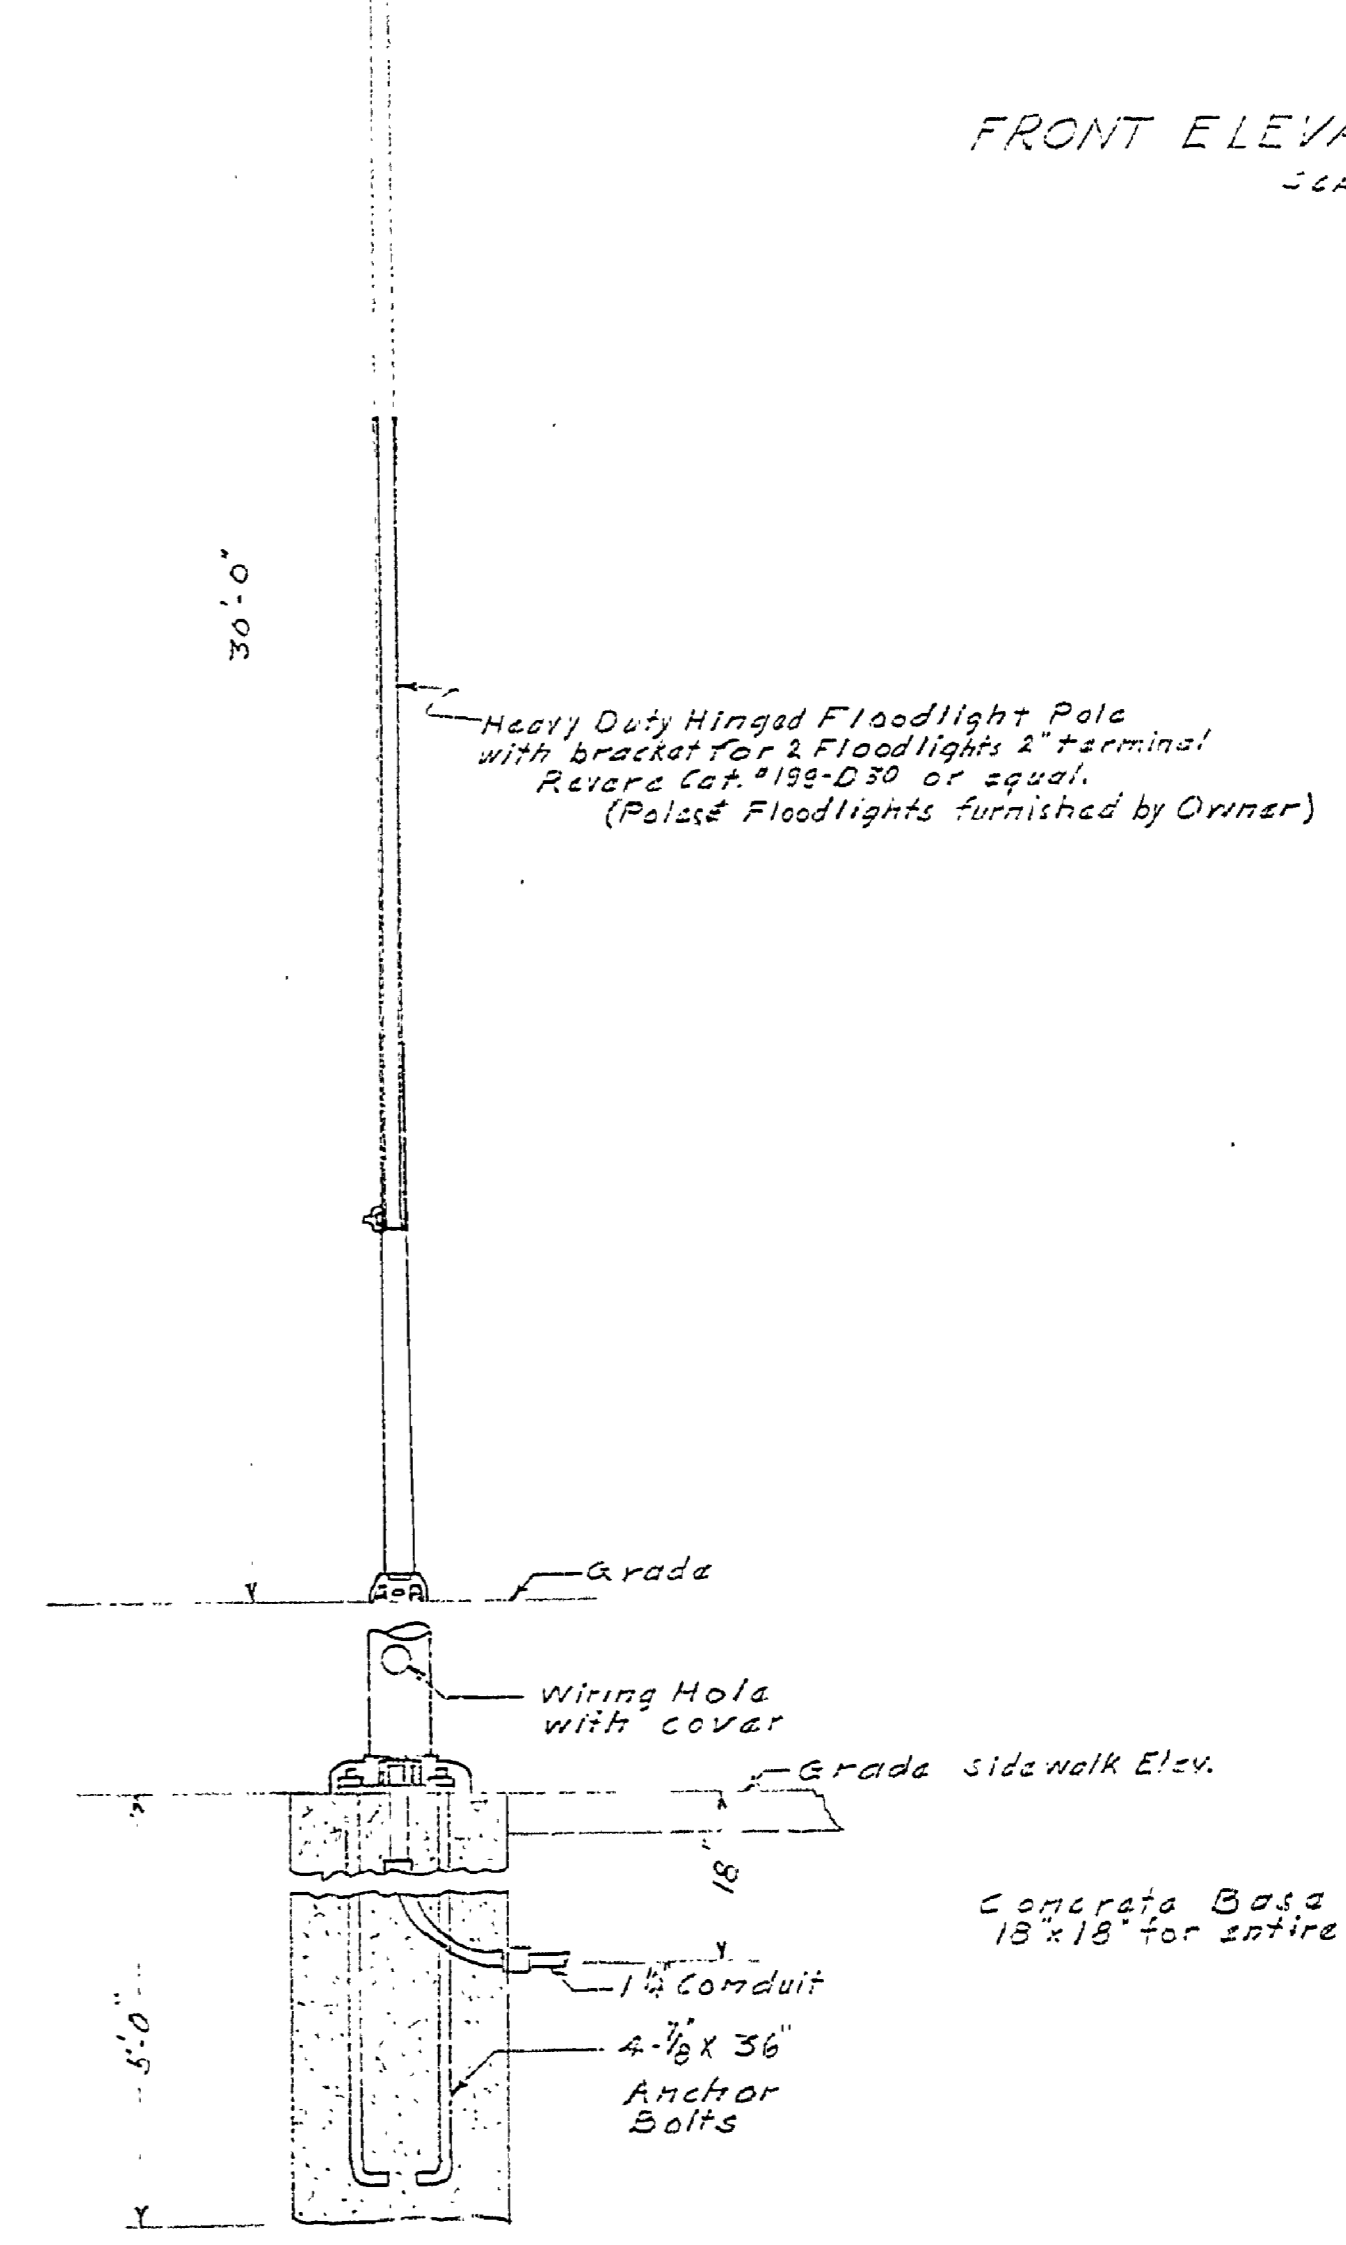

DETAIL OF FLOODLIGHT POLE & BASE
SCALE 3/4"=1'-0"